

CROWN CASTLE/ VERIZON MIV 43

8215 SE 78TH ST

MERCER ISLAND, WA 98040

SITE COORDINATES: 47.532922°, -122.229622°

Seward Park

PROJECT DESCRIPTION

CROWN PROPOSES TO INSTALL A NEW WOOD UTILITY POLE THAT ALLOWS FOR INSTALLATION OF ANENNA/EQUIPMENT, AC POWER & FIBER ON POLE WITH 2 NEW UTILITY VAULTS AT BASE OF POLE IN EXISTING ROW.

DRAWING INDEX

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BUILDING & SITE DATA

JURISDICTION: MERCER ISLAND POLE OWNER:

CROWN CASTLE PROJECT MANAGER: THOMAS JOHNSON CROWN CASTLE 1505 WESTLAKE AVE N, SUITE 800

thomas.iohnson@crowncastle.com

1505 WESTLAKE AVE N. SUITE 800

SIGNATURE

PERMITTING/ZONING CONTACT:

SEATTLE WA 98109 TEL: (206) 336-3230 MOBILE: (808) 561-2499

CROWN CASTLE

May C

SEATTLE WA 98109 TEL: (206) 336-2889 amanda.nations@crowncastle.com

ADDRESS:

ZONING:

PROJECT TEAM

CROWN CASTLE 8215 SF 78TH ST MERCER ISLAND, WA 98040

NODE LOCATION:

FXISTING ROW

NETWORK ANCHOR:

ELECTRICAL ENGINEER:
JASON CEGLIA
MORRISON HERSHFIELD CORP
PHONE: (954) 577-4655

Icooke@morrisonhershfield.com

SIGNATURE BLOCK

CROWN	
PSE	
RF ENGINEER	
CITY OF SEATTLE	

LEGEND & SYMBOLS

---- UGP ---- UG POWER CONDUIT ---- UGT ---- UG TELCO CONDUIT LARGE SCALE DETAIL



PHOTOSIM BUG



ELEVATION BUG

ARRREVIATIONS

		ADL	DIVENIALIONS		
AGL A/C APPROX AZ	ABOVE GROUND LEVEL AIR CONDITIONING APPROXIMATELY AZIMUTH	GA GALV GC GRND GYP BD	GAUGE GALVANIZED GENERAL CONTRACTOR GROUND GYPSUM WALL BOARD	PLYWD PT PROJ PROP (P)	PLYWOOD PRESSURE TREATED PROJECT PROPERTY PROPOSED
BLDG BLK	BUILDING BLOCKING	HT HVAC	HEIGHT HEATING VENTILATION	QTY	QUANTITY
CLG Q CLR CONC CONST	CEILING CENTERLINE CLEAR CONCRETE CONSTRUCTION	HORZ HR	HEATING VENTILATION AIR CONDITIONING HORIZONTAL HOUR	REQ RM RO ROW	REQUIRED ROOM ROUGH OPENING RIGHT OF WAY
CONT	CONTINUOUS	INFO ID	INFORMATION INSIDE DIAMETER	SHT	SHEET SIMILAR
DET DIA DIAG DIM DBL DN DWG	DETAIL DIAMETER DIAGONAL DIMENSION DOUBLE DOWN DRAWING	INSUL INT IBC LBS LF	INSULATION INTERIOR INTERNATIONAL BUILDING CODE POUNDS LINEAR FEET	SPEC SF SS STL STRUCT STD SUSP	SPECIFICATION SQUARE FOOT STAINLESS STEEL STEEL STRUCTURAL STUD SUSPENDED
EA ELEC ELEV EQ	EACH ELECTRICAL ELEVATION EQUAL	MGR MFR MAX MECH	MANAGER MANUFACTURER MAXIMUM MECHANICAL	THRU TNNG TYP	THROUGH TINNED TYPICAL
EQUIP (E) EXT	EQUIPMENT EXISTING EXTERIOR	MTL MIN MISC	METAL MINIMUM MISCELLANEOUS	UG UNO	UNDERGROUND UNLESS NOTED OTHERWISE
FIN FLR FLUOR	FINISH FLOOR FLUORESCENT	N/A NIC	NOT APPLICABLE	VIF VERT	VERIFY IN FIELD VERTICAL
FT	FOOT	NTS	NOT TO SCALE	WP W/	WATER PROOF WITH
		OC OD	ON CENTER OUTSIDE DIAMETER	w/o	WITHOUT

CODE COMPLIANCE

ALL WORK AND MATERIALS SHALL BE PERFORMED AND INSTALLED IN ACCORDANCE WITH THE CURRENT CONDITIONS OF THE FOLLOWING CODES AS ADOPTED BY THE LOCAL GOVERNING AUTHORITIES. NOTHING IN THESE PLANS IS TO BE CONSTRUED TO PERMIT WORK NOT CONFORMING TO THESE CODES:

WASHINGTON STATE AND LOCAL BUILDING CODES WITH THE FOLLOWING REFERENCE CODE:

2015 SEATTLE BUILDING CODE (SBC)
2015 INTERNATIONAL BUILDING CODE (IBC)
2015 INTERNATIONAL MECHANICAL CODE (IMC)
2015 INTERNATIONAL FIRE CODE (IFC)

2017 NATIONAL ELECTRIC CODE (NFPA 70)

NODE LEGEND

N 30th St

Pioneer Park

CROWN #	LAT	LONG	AZIMUTH	ADDRESS	POLE ID #
MIV43	47.532922°	-122.229697°	0,	8215 SE 78TH ST	NEW POLE

*LATITUDE & LONGITUDE ARE FROM CROWN CASTLE (BY OTHERS)

PROFESSIONAL OF RECORD: ROBERT J LARA MORRISON HERSHFIELD CORP

DATE

PHONE: (954) 577-4668

A&E CONTACT:
SHAWN VAN GIESEN
MORRISON HERSHFIELD CORP
600 STEWART ST, SUITE 200
SEATTLE, WA 98101

PHONE: (206) 268-7370 svangiesen@morrisonhershfield.com

ENGINEER OF RECORD: G. LANCE COOKE MORRISON HERSHFIELD CORP PHONE: (503) 595-9128

CROWN	
- PSE	
RF ENGINEER	
CITY OF SEATTLE	



CROWN CASTLE FIBER LLC

PROJECT INFORMATION:

CROWN CASTLE MIV 43

8215 SE 78TH ST MERCER ISLAND, WA 98040

CURRENT ISSUE DATE:

05/20/20

ISSUE FOR:

CONSTRUCTION

SSI	JE HISTOR'	Y:

В	05/20/20	95% FOR REVIEW
Α	04/20/20	90% FOR REVIEW

Revision

Date PLANS PREPARED BY:



600 STEWART STREET, SUITE 200 SEATTLE, WA 98101

www.morrlsonhershfleld.co MH PROJECT #: 190011900

SEAL OF APPROVAL:

SHEET TITLE:

TITLE SHEET & PROJECT INFORMATION

SHEET:

GENERAL NOTES FROSION AND SEDIMENT CONTROLS

- THE CONTRACTOR SHALL BE RESPONSIBLE FOR SURVEY MONUMENTS AND/OR VERTICAL CONTROL BENCHMARKS WHICH ARE DISTURBED OR DESTROYED BY CONSTRUCTION. A LAND SURVEYOR MUST FIELD LOCATE, REFERENCE, AND /OR PRESERVE ALL HISTORICAL OR CONTROLLING MONUMENTS PRIOR TO ANY EARTHWORK. IF DESTROYED, SUCH MONUMENTS SHALL BE REPLACED WITH APPROPRIATE MONUMENTS BY A LAND SURVEYOR. A CORNER RECORD OR RECORD OF SURVEY, AS APPROPRIATE, SHALL BE FILED AS REQUIRED BY THE PROFESSIONAL LAND SURVEYORS ACT.
- 2. IMPORTANT NOTICE: CALL WASHINGTON 811, TOLL FREE 1-800-424-5555, TWO DAYS BEFORE YOU DIG.
- 3. CONTRACTOR SHALL BE RESPONSIBLE FOR THE POT HOLE AND LOCATING OF ALL EXISTING UTILITIES THAT CROSS THE PROPOSED TRENCH LINE AND MUST MAINTAIN A 1' MINIMUM VERTICAL CLEARANCE
- MNY EXISTING HARDSCAPE OF LANDSCAPE INDICATED ON THE APPROVED PLANS IS DAMAGED OR REMOVED DURING DEMOLITION OR CONSTRUCTION, IT SHALL BE REPAIRED AND/OR REPLACED IN KIND PER THE APPROVED PLANS.
- 5. CONTRACTOR SHALL REPAIR OR REPLACE ALL TRAFFIC SIGNAL LOOPS, CONDUIT, AND LANE STRIPING DAMAGED DURING CONSTRUCTION.
- 6. THIS PROJECT SHALL BE INSPECTED BY ENGINEERING AND FIELD ENGINEERING DIVISION.
- MANHOLES OR COVERS SHALL BE LABELED COMMUNICATIONS
- 8. CONTRACTOR SHALL IMPLEMENT AN EROSION CONTROL PROGRAM DURING THE PROJECT CONSTRUCTION ACTIVITIES. THE PROGRAM SHALL MEET THE APPLICABLE REQUIREMENTS OF THE STATE WATER RESOURCE CONTROL BOARD
- 9. THE CONTRACTOR SHALL HAVE EMERGENCY MATERIALS AND EQUIPMENT ON HAND FOR UNFORESEEN SITUATIONS, SUCH AS DAMAGE TO UNDERGROUND WATER, SEWER, AND STORM DRAIN FACILITIES WHEREBY FLOWS MAY GENERATE EROSION AND SEDIMENT POLLUTION.

SPECIAL NOTES

- INDEMNIFICATION CLAUSE: THE CONTRACTOR AGREES AND SHALL:
 ASSUME SOLE AND COMPLETE RESPONSIBILITY OF THE JOB SITE CONDITIONS DURING THE COURSE OF THE
 CONSTRUCTION OF THIS PROJECT, INCLUDING THE SAFETY OF ALL PERSONS AND PROPERTIES. THAT THESE
 REQUIREMENTS SHALL APPLY CONTINUOUSLY AND NOT BE LIMITED TO NORMAL WORKING HOURS AND CONDITIONS.
 THE CONTRACTOR FURTHER AGREES TO DEFEND INDEMNITY AND HOLD EXTENT, REPRESENTATIVES, AND ENGINEERS
 HARMLESS FROM ANY AND ALL LIABILITY, REAL OR ALLEGED, IN CONNECTION WITH THE PERFORMANCE OF THE WORK ON THIS PROJECT.
- 2. PRIOR TO THE BEGINNING OF ANY CONSTRUCTION AND THROUGHOUT THE COURSE OF CONSTRUCTION WORK. THE CONTRACTOR SHALL FULLY COMPLY WITH "WASHINGTON OCCUPATIONAL SAFETY AND HEALTH" ACY OF 1973 INCLUDING ALL REVISIONS AND AMENDMENTS THERETO.
- ALL WORK SHALL CONFORM TO THE LATEST STANDARD "SPECIFICATIONS FOR PUBLIC WORKS CONSTRUCTION" AS ADOPTED BY THE CITY, COUNTY, OR STATE AS MODIFIED BY STANDARD PLANS AND ADDENDUMS.
- 4. THE EXISTENCE AND LOCATION OF UTILITIES AND OTHER AGENTS FACILITIES AS SHOWN HERON ARE OBTAINED BY A SEARCH OF AVAILABLE RECORDS. OTHER FACILITIES MAY EXIST. THE CONTRACTOR SHALL VERIFY PRIOR TO THE START OF CONSTRUCTION AND USE EXTREME CARE AND PROTECTIVE MEASURES TO PREVENT DAMAGE TO THESE FACILITIES. THE CONTRACTOR IS RESPONSIBLE FOR THE PROTECTION OF ALL UTILITY OR AGENCY FACILITIES WITHIN THE LIMITS OF THE WORK, WHETHER THEY ARE SHOWN ON THIS PLAN OR NOT.
- 5. THE CONTRACTOR SHALL NOTIFY THE CITY, COUNTY, OR STATE ENGINEER INSPECTION DEPARTMENT AT LEAST TWO DAYS BEFORE THE START OF ANY WORK REQUIRING THEIR INVOLVEMENT.
- 6. THE CITY, COUNTY, OR STATE SHALL SPECIFY THE EXPIRATION PERIOD OF THE PERMIT FOR THIS CONSTRUCTION
- 7. THE MINIMUM COVER FOR ALL CONDUITS PLACED UNDERGROUND SHALL BE 24" TO THE FINISHED GRADE AT ALL
- 8. THE CONTRACTOR SHALL TUNNEL ALL CURB AND GUTTERS AND BORE ALL CONCRETE DRIVEWAYS AND WALKWAYS ST THE DIRECTION OF THE CITY, COUNTY, OR STATE ENGINEER.
- 9. ALL A.C. AND/OR CONCRETE PAVEMENT SHALL BE REPLACED AT THE DIRECTION OF THE CITY, COUNTY, OR STATE
- 10. ALL SHRUBS, PLANTS OR TREES THAT HAVE BEEN DAMAGED OR DISTURBED DURING THE COURSE OF SHALL BE REPLANTED AND/OR REPLACED SO AS TO RESTORE THE WORK SITE TO ITS ORIGINAL CONDITION.
- 11. THE CONTRACTOR SHALL BE RESPONSIBLE FOR THE PROCESSING OF ALL APPLICANT PERMIT FORMS ALONG WITH THE REQUIRED LIABILITY INSURANCE FORMS. CLEARLY DEMONSTRATING THAT EXTENT, THE CITY, COUNTY OR STATE IS ALSO INSURED WITH THE REQUIRED LIABILITY INSURANCE FOR THIS CONSTRUCTION PROJECT.
- 12. VAULTS, PEDESTALS, CONDUITS AND OTHER TYPES OF SUBSTRUCTURE ARE EITHER SPECIFIED ON THIS PLAN OR WILL BE SPECIFIED BY THE CONSTRUCTION ENGINEER. ANY AND ALL DEVIATIONS FROM THE SPECIFIED TYPES OF MATERIAL MUST BE APPROVED BY THE SYSTEM DESIGNER, IN WRITING, BEFORE INSTALLATION THEREOF.
- 13. THE CONTRACTOR SHALL VERIFY THE LOCATION OF ALL EXISTING UTILITIES, INCLUDING SEWER LATERALS AND WATER SERVICES TO INDIVIDUAL LOTS BOTH VERTICAL AND HORIZONTAL PRIOR TO COMMENCING IMPROVEMENT OPERATIONS.
- 14. CONTRACTOR SHALL MAKE EXPLORATION EXCAVATIONS AND LOCATE EXISTING FACILITIES SUFFICIENTLY AHEAD OF CONSTRUCTION TO PERMIT REVISIONS TO PLANS IF REVISION IS NECESSARY BECAUSE OF LOCATION OF EXISTING UTILITIES.
- 15. THE LOCATIONS OF ALL EXISTING UTILITIES SHOWN ON THESE PLANS ARE FROM EXISTING RECORDS AND CORROBORATED, WHERE POSSIBLE, WITH FIELD TIES. THE CONTRACTOR IS RESPONSIBLE FOR CONFIRMING THE LOCATIONS SHOWN, BOTH HORIZONTALLY AND VERTICALLY, PRIOR TO CONSTRUCTION. IF EXISTING LOCATIONS VAIS SUBSTANTIALLY FROM THE PLANE, THE ENGINEER SHOULD BE NOTIFIED TO MAKE ANY CONSTRUCTION CHANGES

TEMPORARY EROSION/SEDIMENT CONTROL PRIOR TO COMPLETION OF FINAL IMPROVEMENTS SHALL BE PERFORMED BY THE

- CONTRACTOR OR QUALIFIED PERSON AS INDICATED BELOW:
- ALL REQUIREMENTS OF THE CITY, COUNTY, STATE "STORM WATER STANDARDS" MUST BE INCORPORATED INTO THE DESIGN AND CONSTRUCTION OF THE PROPOSED GRADING/MPROVEMENTS CONSISTENT WITH THE APPROVED STORM WATER POLLUTION PREVENTION PLAN (SWPPP). WATER QUALITY TECHNICAL REPORTS (WORT) AND/OR WATER POLLUTION CONTROL PLAN (WPCP)
- 2. FOR STORM DRAIN INLETS, PROVIDE A GRAVEL BAG SILT BASIN IMMEDIATELY UPSTREAM OF INLET AS INDICATED ON
- FOR INLETS LOCATED AT SUMPS ADJACENT TO TOP OF SLOPES, THE CONTRACTOR SHALL ENSURE THAT WATER DRAINING INTO THE SUMP IS DIRECTED INTO THE INLET AND THAT A MINIMUM OF 1.00' OF FREEBOARD EXISTS AND IS MAINTAINED ABOVE THE TOP OF THE INLET. IF FREEBOARD IS NOT PROVIDED BY GRADING SHOWN ON THESE PLANS THE CONTRACTOR SHALL PROVIDE IT VIA TEMPORARY MEASURES: I.E., GRAVEL BAGS OR DIKES.
- 4. THE CONTRACTOR OR QUALIFIED PERSON SHALL BE RESPONSIBLE FOR CLEANUP OF SILT AND MUD ON ADJACENT STREET(S) AND STORM DRAIN SYSTEM DUE TO CONSTRUCTION ACTIVITY
- 5. THE CONTRACTOR OR QUALIFIED PERSON SHALL CHECK AND MAINTAIN ALL LINED AND UNLINED DITCHES AFTER EACH
- 6. THE CONTRACTOR SHALL REMOVE SILT AND DEBRIS AFTER EACH MAJOR RAINFALL.
- 7. EQUIPMENT AND WORKERS FOR EMERGENCY WORK SHALL BE MADE AVAILABLE AT ALL TIMES DURING THE RAINY SEASON. ALL NECESSARY MATERIALS SHALL BE STOCKPILED ON SITE AT CONVENIENT LOCATIONS TO FACILITATE RAPID CONSTRUCTION OF TEMPORARY DEVICES WHEN RAIN IS IMMINENT.
- 8. THE CONTRACTOR SHALL RESTORE ALL SEDIMENT/EROSION CONTROL DEVICES TO WORKING ORDER TO THE SATISFACTION OF THE CITY ENGINEER OR RESIDENT ENGINEER AFTER EACH RUN-OFF PRODUCING RAINFALL.
- 9 THE CONTRACTOR SHALL INSTALL ADDITIONAL FROSION/SEDIMENT CONTROL MEASURES AS MAY BE REQUIRED BY THE RESIDENT ENGINEER DUE TO UNCOMPLETED GRADING OPERATIONS OR UNFORESEEN CIRCUMSTANCES WHICH MAY ARISE.
- 10. THE CONTRACTOR SHALL BE RESPONSIBLE AND SHALL TAKE NECESSARY PRECAUTIONS TO PREVENT PUBLIC TRESPASS ONTO AREAS WHERE IMPOUNDED WATERS CREATE A HAZARDOUS CONDITION. 11. ALL EROSION/SEDIMENT CONTROL MEASURES PROVIDED PER THE APPROVED GRADING PLAN SHALL BE INCORPORATED HEREIN. ALL EROSION/SEDIMENT CONTROL FOR INTERIM CONDITIONS SHALL BE DONE TO THE SATISFACTION OF THE
- 12. GRADED AREAS AROUND THE PROJECT PERIMETER MUST DRAIN AWAY FROM THE FACE OF THE SLOPE AT THE CONCLUSION OF EACH WORKING DAY.
- 13. ALL REMOVABLE PROTECTIVE DEVICES SHOWN SHALL BE IN PLACE AT THE END OF EACH WORKING DAY WHEN RAIN IS
- 14. THE CONTRACTOR SHALL ONLY GRADE, INCLUDING CLEARING AND GRUBBING FOR THE AREAS FOR WHICH THE CONTRACTOR OF QUALIFIED PERSON CAN PROVIDE EROSION/SEDIMENT CONTROL MEASURES.

ROW GROUND CONSTRUCTION NOTES

- 1. 120V POWER REQUIRED FOR ALL 2-WIRE SERVICE
- 2. GENERAL CONTRACTOR TO REMOVE/CLEAN ALL DEBRIS, NAILS, STAPLES, OR NON-USED VERTICALS OFF THE POLE.
- 3. ALL CONSTRUCTION SHALL BE IN ACCORDANCE WITH MUNICIPAL, COUNTY, STATE, AND FEDERAL STANDARDS AND REGULATIONS.
- 4. CALL (811) 48 HOURS PRIOR TO EXCAVATING AT (800) 424-5555
- 5. ALL LANDSCAPING TO BE RESTORED TO ORIGINAL CONDITION OR BETTER.
- 6. ALL EQUIPMENT TO BE BONDED.
- 7. METERING CABINET (IF PLACED) REQUIRES 3' CLEARANCE AT DOOR OPENING.
- 8. CAULK CABINET BASE AT PAD.
- 9. CONTRACTOR TO MAINTAIN NIGHTTIME PEDESTRIAN LIGHTING AS REQUIRED BY CITY.

STANDARD TRENCHING NOTES:

- 1. MAINTAIN 24" MINIMUM COVER FOR ELECTRICAL CONDUIT, OR PER UTILITY REQUIREMENT.
- 2. MAINTAIN 24" MINIMUM COVER FOR ALL COMMUNICATIONS CONDUIT
- 3. IN STREET SLURRY TO GRADE AND MILL DOWN 1-1/2" FOR AC CAP.
- 4. IN DIRT SLURRY 18" FROM GRADE, AND FILL WITH 95% COMPACTION, NATIVE SOIL FOR BALANCE,
- 5. PLACE WARNING TAPE IN TRENCH 12" ABOVE ALL CONDUITS AND #18 WARNING TAPE ABOVE GROUND RING

UTILITY CONSTRUCTION NOTES

- ALL DISCONNECTIONS, TEMPORARY CONNECTIONS & FINAL SERVICE CONNECTIONS WILL BE MADE BY UTILITY. COORDINATE ALL ENERGIZING & DE-ENERGIZING OF STREET LIGHTING SERVICE WITH UTILITY REPRESENTATIVE AS
- CONTRACTOR SHALL COORDINATE WITH UTILITY FOR REMOVING FLOOD LIGHTS & STREETLIGHTS FROM EXISTING POLES PRIOR TO POLE REMOVAL & THE DELIVERY OF ALL THE SALVAGED STREETLIGHT RELATED MATERIALS TO OWNER SALVAGE YARD. NO STREETLIGHT MAY BE DISABLED WITHOUT APPROVAL FROM DEPARTMENT OF TRANSPORTATION OR
- CONTRACTOR SHALL MAINTAIN EXISTING STREET LIGHTING SYSTEM DURING CONSTRUCTION & WILL BE RESPONSIBLE FOR THE COST OF TEMPORARY SYSTEM, IF NECESSARY.
- WORK SHALL BE SCHEDULED SUCH THAT NO TWO (2) ADJACENT OF OPPOSITE STREET LIGHTS ARE DISABLED AT ANY
- ANY EXCAVATION IN PROXIMITY TO AN EXISTING STREETLIGHT POLE MUST BE DONE WITHOUT UNDERMINING ITS STABILITY. CONTRACTOR IS RESPONSIBLE FOR TEMPORARY SUPPORT WHICH MAY BE REQUIRED TO STABILIZE THE POLE.
- CONTRACTOR SHALL CALL FOR AN INSPECTION OF THE STREET LIGHTING SYSTEM AT VARIOUS STAGES OF INSTALLATION/CONSTRUCTION OR AS INSTRUCTED BY UTILITY INSPECTOR.
- CONTACT UTILITY FOR STREET LIGHTING INSPECTION.
- CONTRACTOR WILL ASSIST THE INSPECTOR DURING THE INSPECTION, COMMISSIONING, & FINAL CONNECTION PHASES OF THE PROJECT AS INSTRUCTED BY THE INSPECTOR. SUCH ASSISTANCE WILL INCLUDE, BUT NOT BE LIMITED TO, OPENING HANDHOLES, MANHOLES & VARIOUS ACCESS COVERS, DISCONNECTING & RECONNECTING FUSE HOLDERS & MECHANICAL SPLICE CONNECTIONS, VERIFYING CONDUIT RUNS, ETC.
- 9. CONTRACTOR SHALL CORRECT ALL PUNCH LIST ITEMS & CALL FOR RE-INSPECTION WHERE REQUIRED BY THE
- UPON COMPLETION OF WIRING THE STREETLIGHT SYSTEM, THE CONTRACTOR SHALL PREPARE A RED-LINE WIRING AS-BUILT DIAGRAM. THE DIAGRAM SHALL INCLUDE WHICH DUCT IS USED IN EACH DUCT BANK. CONTRACTOR SHALL PROVIDE THE RED-LINE TO UTILITY ELECTRICAL INSPECTOR PRIOR TO REQUESTING FINAL STREETLIGHT SERVICE
- 11. VACANT CONDUIT SHALL BE STUBBED IN HANDHOLE. REPLACE WITH: PULL TAPE INSTALLED THROUGH THE CONDUIT &
- 12. ALL WIRING, INCLUDING STREET LIGHTING & PEDESTRIAN LIGHTING CIRCUITS SHALL BE CLEARLY LABELED PER UTILITY CONSTRUCTION STANDARD
- 13. COORDINATE WITH THE CIVIL CREW & REMOVE ALL EXISTING WIRING.
- 14. STREETLIGHT SYSTEM GROUNDING & BONDING SHALL BE PER UTILITY CONSTRUCTION STANDARD.
- 15. EXISTING TREES SHALL BE PROTECTED DURING CONSTRUCTION PROCESS. NO TREE TRIMMING WITHOUT WRITTEN

MORRISON HERSHFIELD

SEATTLE, WA 98101 Tel: 206.268.7370 www.morrlsonhershfleld.cor

MH PROJECT #: 190011900 NETWORK ANCHOR:

STANDARD GROUNDING NOTES

- CONTRACTOR TO PROVIDE GROUND TEST VERIFICATION AT 25 OHMS OR LESS. CONTRACTOR TO TEST PER CROWN DOC# 337910 AND SUBMIT SCS GROUND RESISTANCE FORM TO CROWN CONSTRUCTION MANAGER. WITH CLOSE OUT PACKAGE
- 2. UTILIZE MIN. OF #6 AWG INSULATED GREEN GROUND WIRE MINIMUM ABOVE GRADE & #2 MINIMUM BARE TINNED GROUND WIRE UNDERGROUND TO MGB UNLESS OTHERWISE NOTED THESE DRAWINGS
- 3. PLACE (1) 5/8"x10" ROD, WITH A CAD WELDED #2 BARE TINNED GROUND WIRE TO EQUIPMENT GROUND BAR ON POLE. CONTRACTOR IS TO ADD A SECOND GROUND ROD 6" AWAY W/#6 BARE COPPER WIRE 4" BELOW GRADE IF GROUND TEST FAILS TO MEET 25 OHMS OR LESS OR AS
- 4. SECOND GROUND ROD REQUIRED ON WOOD POLES W/DISTRIBUTION POWER OR ON ANY POLE THAT DOESN'T MEET 25 OHMS OR LESS GROUNDING REQUIREMENT. MINIMUM SEPARATION SHALL BE 8'
- 5. MOLDING GALVANIZED STAPLED EVERY 24" AND AT 12" FROM EACH END OVER GROUND WIRE AT BASE OF WOOD POLE TO 8' AGL
- 6. PLACE GROUND ROD(S) 3' FROM POLE OR AS DIRECTED BY CROWN CONSTRUCTION MANAGER
- 7. INSTALL GROUND SYSTEM PER NESC, UTILITY & CROWN DOC# 337910

GROUND TIE CHECKLIST

- ☐ GROUND ROD(S) W/CADWELD
- ☐ METAL POLE BASE (IF APPLICABLE) □ DISCONNECT
- ☐ MINI MASTER GROUND BAR & EQUIPMENT LEVEL
- □ RRU ☐ RRU SHROUD (IF APPLICABLE)
- ☐ ANTENNA(S)
- ☐ PROPOSE COMM MESSENGER
- ☐ EXISTING COMM MESSENGER
- ☐ ANTENNA COAX
- ☐ UFER GROUND COILED FOR LIGHT POLES
- ☐ REBAR CAGE FOR LIGHT POLES

STANDARD CONDUIT NOTES

- 1. FOR UNDERGROUND USE SCHEDULE: A. SCHEDULE 80 [POWER]
 - A. SCHEDULE 40 [COAX]
 B. SCHEDULE 80 [POWER]

2. FOR RISERS OR INTERNAL USE SCHEDULE:

- 3. PLACE 2" SDR-11 RED CONDUIT FOR UG POWER APPLICATIONS OR 3" SCH 80 AS DIRECTED.
- 4. RISERS TO BE ATTACHED TO STAND OFFS.
- 5. RISERS U-CLAMPS TO BE INSTALLED EVERY 5'.
- 6. CONDUIT UNDER 1" MAY BE ATTACHED WITH GROUND WIRE MOULDING STAPLES IN CROTCH OF POLE.
- 7. ALL CONDUIT WILL BE PROOFED WITH A MANDREL AND EQUIPPED WITH PULL ROPE OR MULE TAPE.



CROWN CASTLE FIBER LLC

PROJECT INFORMATION:

CROWN CASTLE MIV 43

8215 SE 78TH ST MERCER ISLAND, WA 98040

CURRENT ISSUE DATE:

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ISSUE HISTORY: 05/20/20 95% FOR REVIEW 04/20/20 90% FOR REVIEW Date Revision

PLANS PREPARED BY:


600 STEWART STREET, SUITE 200

SEAL OF APPROVAL:

SHEET TITLE:

GENERAL NOTES

SHEET:

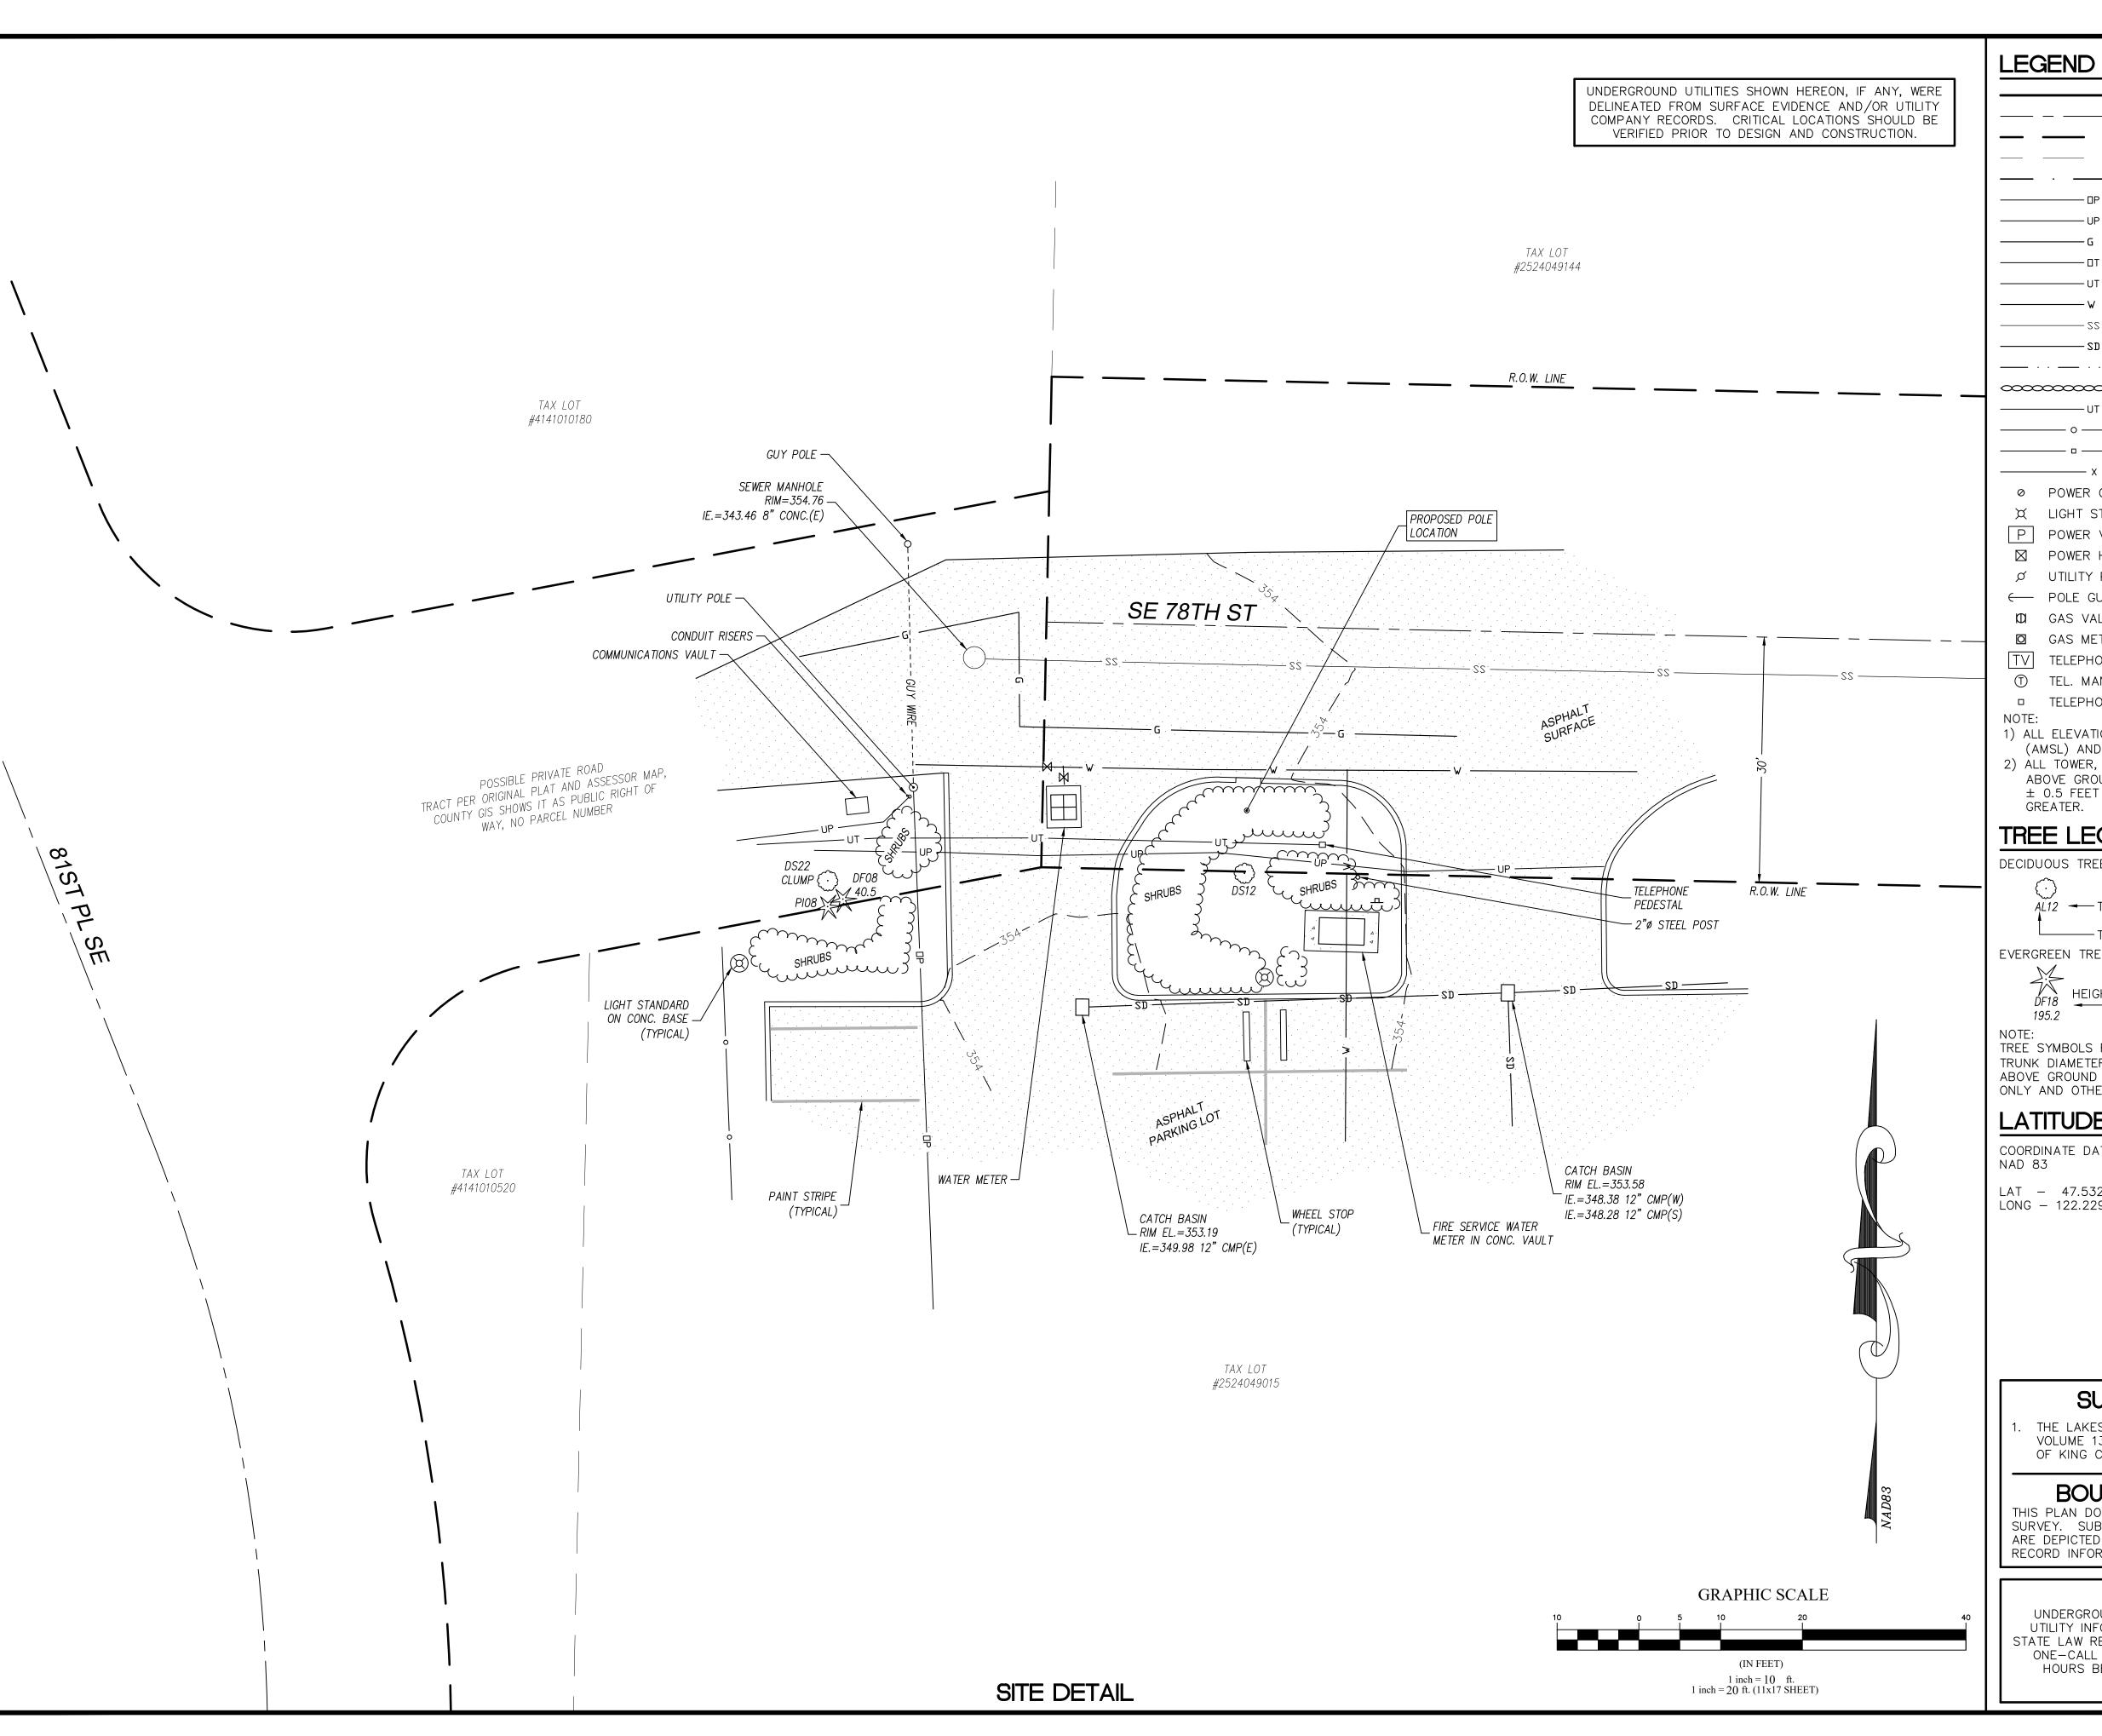

- SUBJECT BOUNDARY LINE - RIGHT-OF-WAY CENTERLINE --- RIGHT-OF-WAY LINE - ADJACENT BOUNDARY LINE ---- SECTIONAL BREAKDOWN LINE - OVERHEAD POWER LINE - BURIED POWER LINE - BURIED GAS LINE OVERHEAD TELEPHONE LINE - BURIED TELEPHONE LINE - BURIED WATER LINE - BURIED SANITARY SEWER - BURIED STORM DRAIN · - DITCH LINE/FLOW LINE ROCK RETAINING WALL - UNDERGROUND TELEPHONE - CHAIN LINK FENCE - WOOD FENCE - BARBED WIRE/WIRE FENCE -Q- FIRE HYDRANT X LIGHT STANDARD M GATE VALVE P POWER VAULT ■ WATER METER Q FIRE DEPT. CONNECTIO Ø UTILITY POLE IRRIGATION CONTROL ☐ CATCH BASIN, TYPE ← POLE GUY WIRE CATCH BASIN, TYPE II D GAS VALVE GAS METER **≖** SIGN TV TELEPHONE VAULT BOLLARD TEL. MANHOLE □ MAIL BOX TELEPHONE RISER L.S. LANDSCAPING 1) ALL ELEVATIONS SHOWN ARE ABOVE MEAN SEA LEVEL

(AMSL) AND ARE REFERENCED TO THE NAVD88 DATUM. 2) ALL TOWER, TREE AND APPURTENANCE HEIGHTS ARE ABOVE GROUND LEVEL (AGL) AND ARE ACCURATE TO \pm 0.5 FEET OR \pm 1% OF TOTAL HEIGHT, WHICHEVER IS

TREE LEGEND

AL=ALDER DECIDUOUS TREE MP=MAPLE DS=DECIDUOUS AL12 TRUNK DIAMETER (IN) MA=MADRONA OK=OAK CH=CHERRY CE=CEDAR EVERGREEN TREE


DF=DOUGLAS FIR HE=HEMLOCK DF18 HEIGHT AGL IF MEASURED PI=PINE EVG=EVERGREEN

TREE SYMBOLS REFERENCE TRUNK LOCATION ONLY. TRUNK DIAMETERS WERE APPROXIMATED AT 3.5' TO 4' ABOVE GROUND LEVEL. TREES SHOWN ARE FOR REFERENCE ONLY AND OTHER TREES AND VEGETATION MAY EXIST.

LATITUDE/LONGITUDE POSITION

COORDINATE DATA AT PROPOSED POLE LOCATION:

LAT - 47.532922° N NAVD 88 LONG - 122.229697° W ELEV.=354.2 FEET

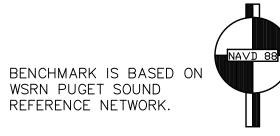

SURVEY REFERENCE

THE LAKES AT MERCER ISLAND DIV. 2 PLAT, PER VOLUME 131 OF PLATS, PAGES 17—22, RECORDS OF KING COUNTY.

BOUNDARY DISCLAIMER

THIS PLAN DOES NOT REPRESENT A BOUNDARY SURVEY. SUBJECT AND ADJACENT PROPERTY LINES ARE DEPICTED USING FIELD-FOUND EVIDENCE AND RECORD INFORMATION.

CAUTION!

UNDERGROUND UTILITIES EXIST IN THE AREA AND UTILITY INFORMATION SHOWN MAY BE INCOMPLETE. STATE LAW REQUIRES THAT CONTRACTOR CONTACT THE ONE-CALL UTILITY LOCATE SERVICE AT LEAST 48 HOURS BEFORE STARTING ANY CONSTRUCTION.


1-800-424-5555



1505 WESTLAKE AVE N, SUITE 800 SEATTLE, WA 98109



600 Stewart Street, Suite 200 Seattle, WA 98101 Tel: 206.268.7370 www.morrisonhershfield.com

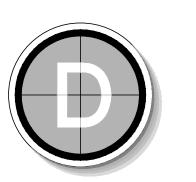

DUNCANSON

Company, Inc. 145 SW 155th Street, Suite 102 Seattle, Washington 98166 Phone 206.244.4141 Fax 206.244.4455

MIV43

8215 SE 78TH ST

MERCER ISLAND, WA 98040 KING COUNTY THIS DRAWING WAS CREATED FOR THE

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FLD. CREW: JR/D(546/96 FLD. BOOK: DRAWN BY: LAC JOB #: 04168.229

DATE:


04/08/20

REVISIONS				
DATE	DESCRIPTION	BY		



SHEET TITLE EXISTING SITE SURVEY SEC 25, TWP 24 N, RNG 4 E, WM

> SHEET NUMBER SV1

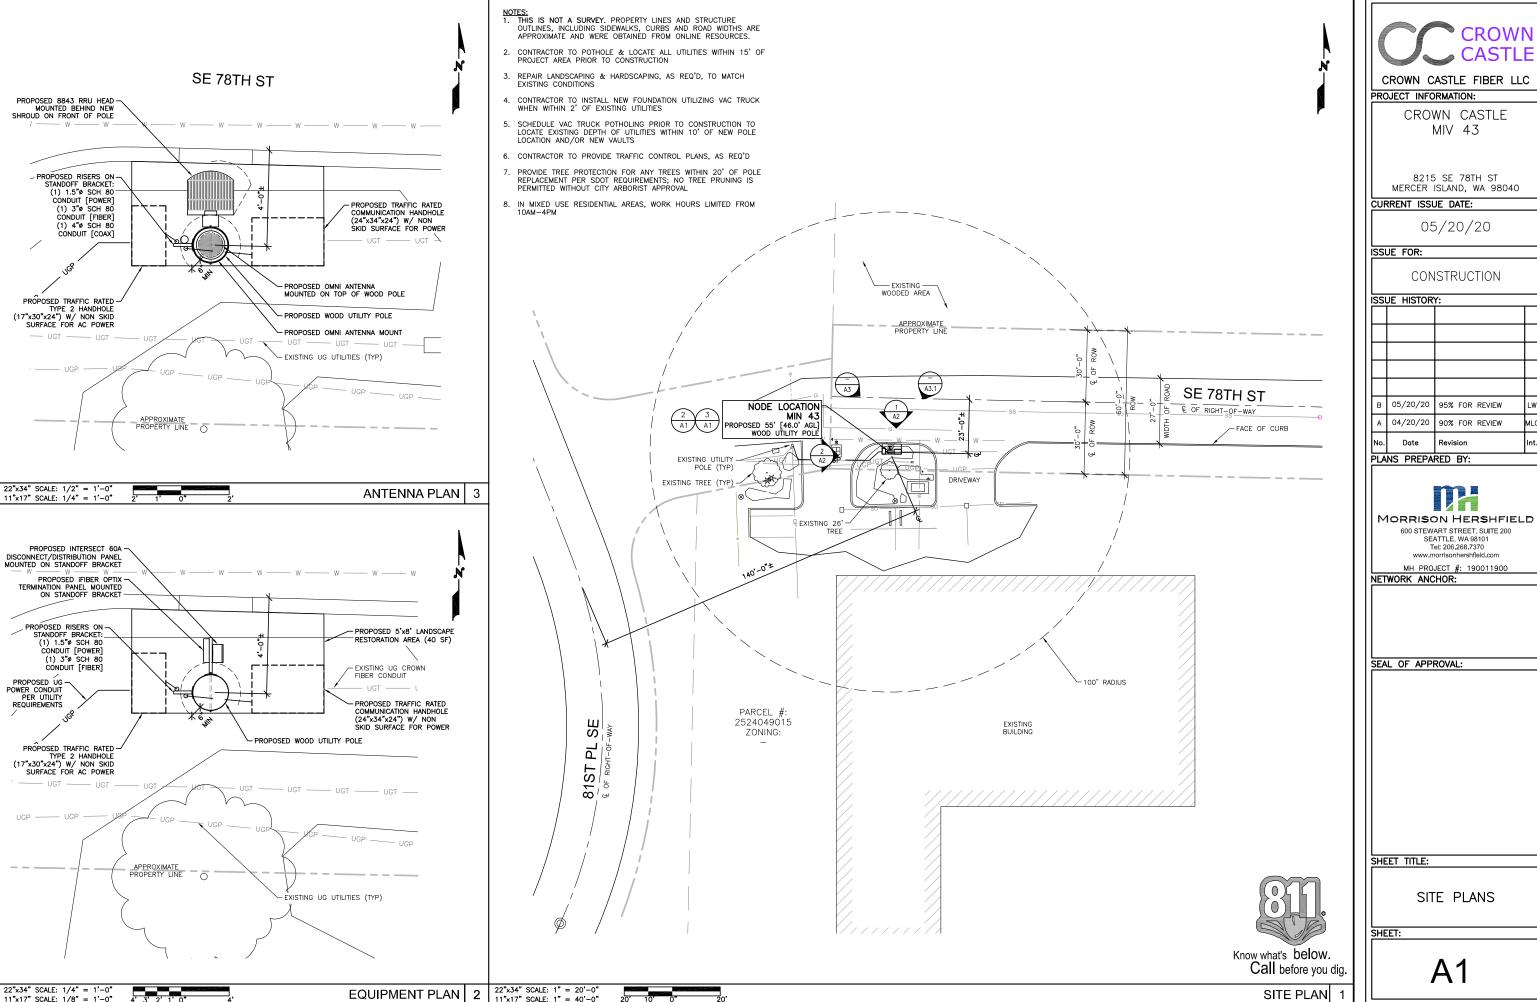

CROWN CASTLE FIBER LLC

CROWN CASTLE MIV 43


8215 SE 78TH ST MERCER ISLAND, WA 98040

CONSTRUCTION

05/20/20 95% FOR REVIEW 90% FOR REVIEW

SEATTLE, WA 98101 Tel: 206.268.7370 www.morrisonhershfield.com

PAINT NOTE:
ALL ANTENNAS, EQUIPMENT,
CONDUIT, VISIBLE MOUNTING
HARDWARE AND COAX SHALL BE
PAINTED TO MATCH POLE

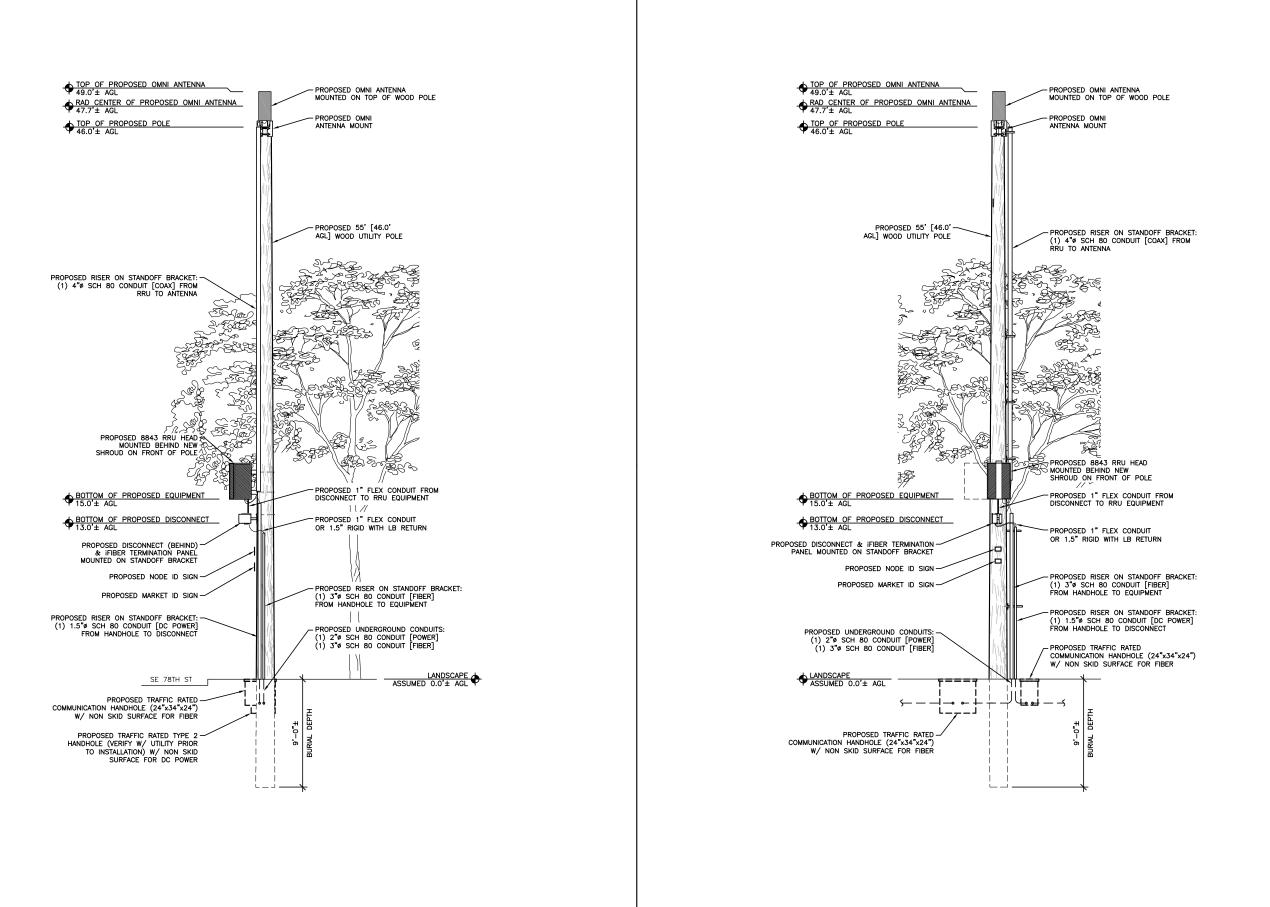

22"x34" SCALE: 1/4" = 1'-0" 11"x17" SCALE: 1/8" = 1'-0"



CROWN CASTLE FIBER LLC

PROJECT INFORMATION:

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8215 SE 78TH ST MERCER ISLAND, WA 98040

CURRENT ISSUE DATE:

05/20/20

ISSUE FOR:

CONSTRUCTION

B 05/20/20 95% FOR REVIEW L
A 04/20/20 90% FOR REVIEW M

PLANS PREPARED BY:



MORRISON HERSHFIELD
600 STEWART STREET, SUITE 200

SEATTLE, WA 98101 Tel: 206.268.7370

MH PROJECT #: 190011900

NETWORK ANCHOR:

SEAL OF APPROVAL:

SHEET TITLE:

ELEVATIONS

SHEET:

A2

ELEVATION 2 22"x34" SCALE: 1/4" = 1'-0" 4 3' 2' 1' 0" 4' ELEVATION





NOTE:
POLE POSITION IN SIMULATION IS APPROXIMATE & MAY
SHIFT BY 3' IN EACH DIRECTION FOR FINAL INSTALLATION

CROWN CASTLE FIBER LLC

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MORRISON HERSHFIELD

600 STEWART STREET, SUITE 200 SEATTLE, WA 98101 Tel: 206.268.7370 www.morrlsonhershfleld.com

MH PROJECT #: 190011900
NETWORK ANCHOR:

SEAL OF APPROVAL:

SHEET TITLE:

PHOTOSIM 1

SHEET:

A3





NOTE:
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MH PROJECT #: 190011900
NETWORK ANCHOR:

SEAL OF APPROVAL:

SHEET TITLE:

PHOTOSIM 2

SHEET:

A3.1



CC CROWN 888-632-0931

NEW SIGN 1: "NOTICE"

RF "NOTICE" SIGN AVAILABLE IN 4"x6" METAL OR 4"x6" ADHESIVE BACKED LABEL

LOCATION: 1' BELOW DISCONNECT

(CAUTION) Keep Back ____ FT From This Antenna, FCC RF Public Exposure Limits May Be Exceeded Within This Distance. Call 888-632-0931 For Instructions Qualified Workers: FCC Occupational Limits May Be Exceeded Within This Distance Site ID#

NEW SIGN 2: "RF WARNING"

RF "CAUTION" SIGN AVAILABLE IN 8"x8" ADHESIVE PLASTIC PLACARD. ADHESIVE SHOULD BE USED WHEN PLACING DIRECTLY ON THE ANTENNA.

LOCATION: 4' BELOW ANTENNA

CROWN CASTLE DAS

24-HOUR EMERGENCY # 888-632-0931

SHROUD SIGN

SHROUD SIGN AVAILABLE IN 4"x4" METAL OR 4"x4" ADHESIVE BACKED LABEL

LOCATION: ON SHROUD (IF NO SHROUD THEN SIGN IS NOT REQUIRED)



"MARKET ID SIGN"

MARKET ID SIGN AVAILABLE IN 4"x6" METAL OR 4"x6" ADHESIVE BACKED LABEL LOCATION: 2' BELOW DISCONNECT


ISOMETRIC VIEW

PLAN VIEW

CHARLES (OR APPROVED ALTERNATE OF FOUAL SIZE) SHRD60-362322 MODEL . DIMENSIONS: 36.0"x23.0"x22.0" 275 (MAX LOAD) 10.54 CU FT VOLUME:

NOTE: 1. INSTALL PER MFR SPECIFICATIONS

- 2. USE POLE MOUNTING PLATE WITH THRU-BOLT © UTILITY POLES
- 3. PAINT TO MATCH POLE
- 4. UTILIZE MANUFACTURER PROVIDED 6" STANDOFF

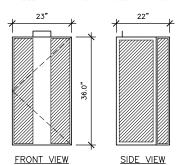

MC-MNT-TOP-2

General Specifications

Application Outdoor

Includes Brackets | Hardware **Package Quantity**

Mechanical Specifications

Color Material Type Galvanized steel

Dimensions

Compatible Diameter, maximum 215.9 mm | 8.5 in Compatible Diameter, minimum 160.0 mm | 6.3 in **Net Weight** 12.0 kg | 26.5 lb

ISSUE FOR:

22"x34" SCALE: NOT TO SCALE 22"x34" SCALE: NOT TO SCALE 22"x34" SCALE: NOT TO SCALE SIGNAGE 5 SHROUD SPECIFICATIONS ANTENNA MOUNT 4 11"x17" SCALE: NOT TO SCALE 11"x17" SCALE: NOT TO SCALE 11"x17" SCALE: NOT TO SCALE

14 PORT QUASI OMNI SMALL CELL ANTENNA WITH LOW BAND

NNVVSSP-360S-FM

360° QUASI OMNI FOR 4T4R

14 PORTS (4.3-10 CONNECTORS)

- 4 PORTS 698-960 MHz
- 4 PORTS 1695-2690 MHz
- 4 PORTS 3.5 GHz (CBRS)
- 2 PORTS 5 GHz (LAA)

COMPACT PACKAGE (~2.4 ft x 12 in)

BEAMFORMING 790 MHz VBW: ~35°

MANUAL ELECTRICAL TILT FOR MID BAND (AWS/PCS) - 5-15°

MECHANICAL SPECIFICATIONS

RF CONNECTOR QUANTITY, TOTAL RF CONNECTOR QUANTITY, LOW BAND 4 RF CONNECTOR QUANTITY, HIGH BAND 10

RF CONNECTOR INTERFACE 4.3-10 FEMALE

RF CONNECTOR INNER CONDUCTOR AND BODY GROUNDING TYPE GROUNDED TO REFLECTOR AND MOUNTING BRACKET

RADIATOR MATERIAL ALUMINUM / LOW LOSS CIRCUIT BOARD

RADOME MATERIAL ASA, UV STABILIZED

REFLECTOR MATERIAL ALUMINUM RF CONNECTOR LOCATION воттом


WIND LOADING, FRONTAL 154.0 N @ 150 km/h 34.6 lbf @ 150 km/h WIND SPEED, MAXIMUM 241 km/h / 150 mph

DIMENSIONS

LENGTH 730.0 mm / 28.7 in OUTER DIAMETER NET WEIGHT, WITHOUT MOUNTING KIT 14.0 kg / 30.9 lb CUBIC VOLUME

305.0 mm / 12.0 in 5.72 CU FT



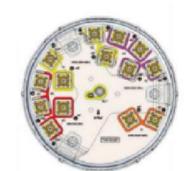



Specification	Eriesson Radio 8843
Band(s)	LTE Band 4 (AWS)
Output power	2 x 40W (up to 2 x80W)
Power consumption	1363W (100% load)
Power supply	-38 to 58.5 VDC (3 wire) power
Physical dimensions	18.4" (height) x 12.5" (width) x 4.5" (depth)
Weight	75 lbs
Connectors	твс

CROWN CASTLE
CROWN CASTLE FIBER LLC

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iss	ue histor	Y:			
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A	04/20/20	90% FOR REVIEW	ML		
No.	Date	Revision	Int		
1 51.4	DI ANC DDEDADED DV.				

PLANS PREPARED BY:



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MH PROJECT #: 190011900

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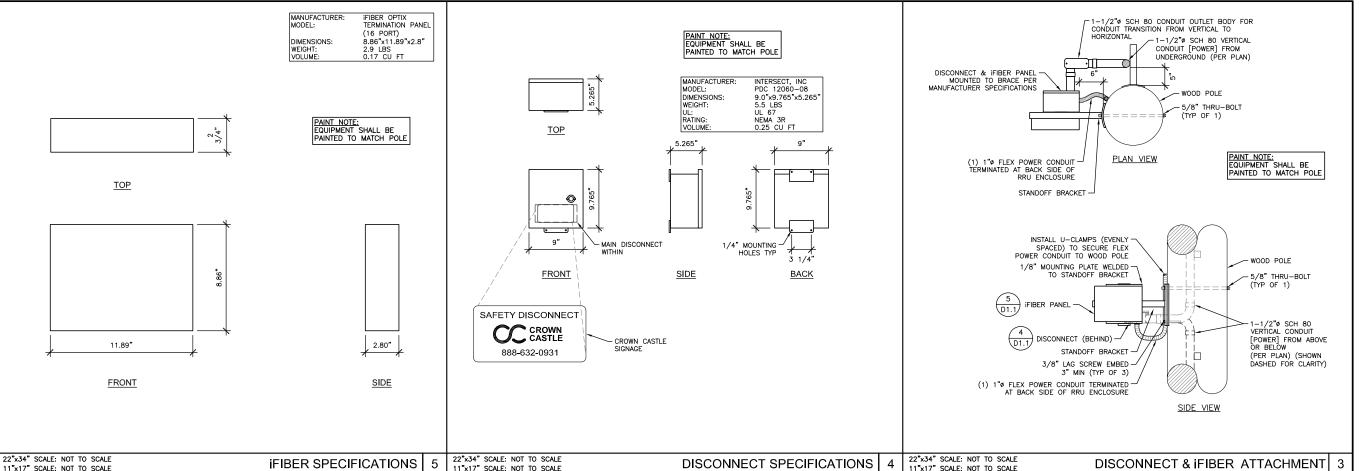
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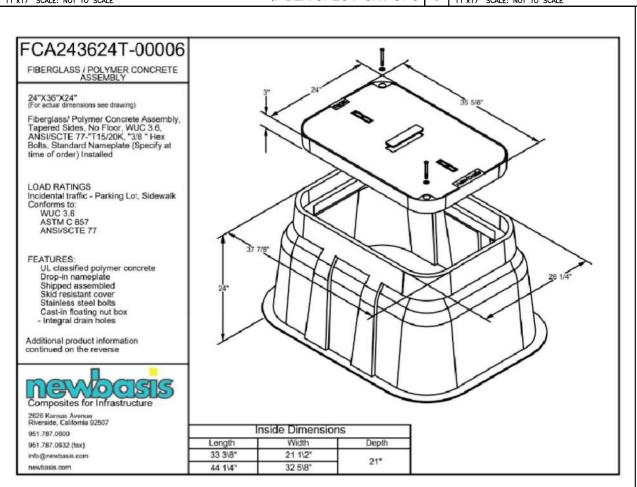
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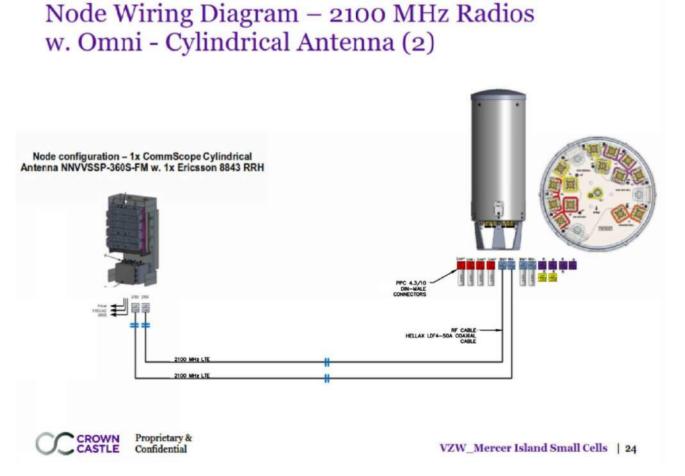
CONSTRUCTION **DETAILS**


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22"x34" SCALE: NOT TO SCALE 11"x17" SCALE: NOT TO SCALE 22"x34" SCALE: NOT TO SCALE ANTENNA SPECIFICATIONS 2 RADIO SPECIFICATIONS 11"x17" SCALE: NOT TO SCALE







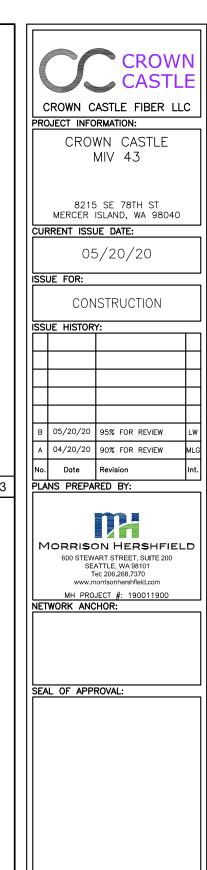

SHEET TITLE:

CONSTRUCTION DETAILS

SHEET:

D1.1

